

City of Plymouth Zoning Board of Appeals Regular Meeting Agenda

Thursday, July 1, 2021 – 7:00 p.m. ONLINE Zoom Webinar

City of Plymouth 201 South Main Street Plymouth, Michigan 48170 www.plymouthmi.gov Phone 734-453-1234 Fax 734-455-1892

Join Zoom Webinar:

https://us02web.zoom.us/j/82878634186?pwd=RmRUY3NsRUNtVGhJMWF1N1k5TEFQZz09

Webinar ID: 828 7863 4186

Passcode: 175215

Statement of explanation of the reason why the public body is meeting electronically:

On March 10, 2020 the Governor of the State of Michigan declared a State of Emergency across the State of Michigan under section 1 of Article 5 of the Michigan Constitution of 1963, the Emergency Management Act, 1976 PA 390, as amended, MCL 30.401 – 421, and the Emergency Powers of the Governor Act of 1945, 1945 PA 302, as amended, MCL10.31 – 33. These sections provide the governor with broad powers and duties to cope with dangers to this state or to the people of the state.

As a part of the response to the emergency, the Governor has deemed it reasonable and necessary to temporarily suspend rules and procedures relating to physical presence at meetings and hearings of public bodies and other governmental entities in Michigan. These public bodies and entities must continue to conduct public business during this emergency.

- 1) CALL TO ORDER
 - a) Roll Call
- 2) CITIZEN COMMENTS
- 3) APPROVAL OF THE MINUTES
 - a) Approval of the June 3, 2021, meeting minutes
- 4) APPROVAL OF THE AGENDA
- 5) OLD BUSINESS
- 6) **NEW BUSINESS**
 - a) **Z 21-14**: 1112 Hartsough, non-use variance for distance between house & garage and Side yard setback for a detached garage.
- 7) **COMMISSIONER COMMENTS**
- 8) REPORTS AND CORRESPONDENCE
- 9) ADJOURNMENT

<u>Citizen Comments</u> - This section of the agenda allows up to 3 minutes to present information or raise issues regarding items not on the agenda. Upon arising to address the Commission, speakers should first identify themselves by clearly stating their name and address. Comments must be limited to the subject of the item.

Persons with disabilities needing assistance should contact the City Clerk's office at 734-453-1234 Monday through Friday from 8:00 a.m. -4:30 p.m., at least 24 hours prior to the meeting. An attempt will be made to make reasonable accommodations.

City of Plymouth Strategic Plan 2017-2021

GOAL I - QUALITY OF LIFE

OBJECTIVES

Support the neighborhoods with high-quality customer service

Engage in collaboration with private entities and surrounding municipalities to implement the Joint Recreation Master Plan

Improve communication with the public across multiple platforms

Maintain a high level of cleanliness throughout the City

Support and host a diverse variety of events that foster community and placemaking

ONE-YEAR TASKS 2021

Restore sports and recreational programs that were halted by COVID-19 as soon as possible

Review and evaluate the special event policy with safety considerations

Address challenges with the Kellogg Park improvements with safety considerations

Move Kellogg Park Fountain project forward

Continue to re-engage service clubs to help enhance parks and public properties

Increase followers by 2,000 on all our communications platforms

Develop an internal and external communications plan

Upgrade City Hall facilities to accommodate remote meetings and remote participation

Continue investigating multi-modal transportation opportunities

Revisit noise ordinance

GOAL II - FINANCIAL STABILITY

OBJECTIVES

Approve balanced budgets that maintain fiscal responsibility

Advocate for increased revenue sharing with the State of Michigan

Encourage and engage in partnerships, both public and private, to share costs of services and equipment

Address the issue of legacy costs

Seek out and implement efficient and effective inter-departmental collaboration

Market our successes to attract new economic and investment opportunities

ONE-YEAR TASKS 2021

Identify mechanisms for funding sources for capital improvement projects

Increase funding to the Public Improvement Fund

Create a potential package for financing emergency structural repairs

Develop a comprehensive asset management plan that includes a review of the equipment fleet

Search out other possible revenue streams through continued association with the CWW and the MML

Develop a financial plan for public safety

Continue to make extra payments towards legacy costs

Monitor outside influences on our revenue sources, including unfunded mandates, the 35th District Court and the PCCS

Negotiate three labor contracts

GOAL III - ECONOMIC VITALITY

OBJECTIVES

Continue to support and improve active, vibrant downtown branding

Support community and economic development projects and initiatives

Support a mix of industrial, commercial and residential development

Reference the $\underline{\text{Master Plan}}$ in economic decision-making

ONE-YEAR TASKS 2021

Complete Saxton's development

Develop municipal parking lot at Saxton's site

Support development of 23 parcels adjacent to the Starkweather School property

Continue to administer the grant and the brownfield plan to support the Pulte project's completion

Finish Redevelopment Ready Community (RRC) certification by the end of 2021

Develop an annual training calendar for the Planning Commission, the Historic District Commission, the Zoning Board of Appeals and the DDA, and identify a funding source

Implement temporary plans to assist businesses in recovery efforts

GOAL IV - SERVICE AND INFRASTRUCTURE

OBJECTIVES

 $Support\ administration\ and\ staff\ by\ providing\ professional\ development\ opportunities, supplying\ resources,\ and\ maintaining\ a$

commitment to recruitment, retention, succession planning

Support and deliver safe and responsive emergency services

Maintain a sophisticated and responsive technology to communicate and manage data

Continually record, maintain, update, and improve City infrastructure

ONE-YEAR TASKS 2021

Explore enhanced pedestrian safety opportunities into targeted intersections

Research funding opportunities for ADA compliance at the PCC

Implement 2021 infrastructure program

Continue training for future career development and succession planning

Conduct a traffic study to determine whether to make additional streets one way

Update mapping resources including parcel data, completing 50% by the end of the year

Update/replace current technology to ensure compliance with new regulations, rules, and operating systems Revisit paid parking



City of Plymouth Zoning Board of Appeals Regular Meeting Minutes Thursday, June 3, 2021 - 7:00 p.m.

City of Plymouth 201 S. Main Plymouth, Michigan 48170-1637 www.plymouthmi.gov Phone 734-453-1234 Fax 734-455-1892

Online Zoom Meeting

1. CALL TO ORDER

Chair Joe Elliott called the meeting to order at 7:00 p.m.

Present: Chair Elliott, Members Jim Burrows, Mike Devine, Ed Krol, Scott Silvers (arrived at 8:14)

Also present: Assistant Community Development Director Greta Bolhuis

Elliott noted that Mike Gowen has moved from the City of Plymouth and has resigned from the Zoning Board of Appeals.

2. CITIZENS COMMENTS

There were no citizen comments.

3. APPROVAL OF THE MEETING MINUTES

Krol offered a motion, seconded by Burrows, to approve the amended minutes (correcting a misspelled name) of the May 6, 2021 meeting.

There was a roll call vote.

Yes: Burrows, Devine, Elliott, Krol

MOTION PASSED 4-0

4. APPROVAL OF THE AGENDA

Burrows offered a motion, seconded by Krol, to approve the agenda for June 3, 2021.

There was a roll call vote.

Yes: Burrows, Devine, Elliott, Krol

MOTION PASSED 4-0

5. OLD BUSINESS

There was no old business.

6. NEW BUSINESS

a. Z21-10: 1012 William - non-use variance for front yard fence height

Applicant Katie Cerne described the proposed project, which would replace a non-conforming fence with one of the same size, length, and approximate style.

Citizen Comments

There were no citizen comments.

Board Comments

A discussion about fence heights and the impact of a fence on this particular property ensued.

Devine offered a motion, seconded by Krol, to grant a variance for request Z21-10 to allow a 6-inch variance to the existing requirement for a maximum 30-inch fence to allow a 36-inch-high fence.

Findings of Fact

The home is located on a busy intersection.

There is negligible rear yard associated with the property.

The existing non-conforming fence could be repaired incrementally over time without the need for a variance.

Conditions

Variance is limited to the type of fence indicated in the application.

Homeowner must provide administration with documentation and dimensions for the existing fence.

The fence shall be at least 50% open and with pickets spaced no wider than 4 inches.

There was a roll call vote.

Yes: Burrows, Elliott, Krol, Silvers

MOTION PASSED 4-0

b. Z21-11: 290 E. Pearl – non-use variance for front yard setback for an attached front-facing garage.

Applicants Gloria and Steven Korpus presented the proposal and request.

Citizen Comments

There were no citizen comments.

Board Comments

Board members questioned the applicant about the decision to build an attached vs. unattached garage and the challenges the property presents.

Burrows offered a motion, seconded by Krol, to approve a five-foot setback variance to place the attached garage closer to the front property line.

Finding of Facts

The existing house is located close to the front property line and the resulting attached garage is as far back as possible while still attaching to the existing house.

The property is unique in that it is so close to the railroad tracks and commercial businesses.

The proposed garage will improve safety and walkability.

There was a roll call vote.

Yes: Burrows, Devine, Elliott, Krol

MOTION PASSED 4-0

c. Z21-12: 690 Junction, non-use variance for front yard setback for new building and front yard fence height

Consumer's Energy spokesperson Jacob Kuehnlein explained the request.

Citizen Comments

There were no citizen comments.

Board Comments

Board members asked Kuehnlein about federal regulations as they pertain to the project. They also discussed the location and the need for security at the facility.

Krol offered a motion to accept variance Z21-12 as submitted to allow a 7-foot fence and a new building with a 14-foot front yard setback as submitted in the application. Burrows seconded the motion.

Findings of Fact

There is a need for added security due to the unique mechanical restrictions associated with the property and its

relationship to surrounding parcels.

The building and fence are in compliance with the MPSC and federal regulations.

There was a roll call vote.

Yes: Burrows, Devine, Elliott, Krol

MOTION PASSED 4-0

d. Z21-13: 1250 S. Main, non-use variance for landscaping

Applicant Silvia Canzano reiterated her request for a landscaping variance in the parking lot of her building.

Citizen Comments

There were no citizen comments.

Board Comments

There was considerable discussion between the applicant and the board about the approved site plan and the size of the parking lot. It was mentioned that the applicant has an agreement with neighboring businesses to share parking.

Elliott offered a motion, seconded by Krol, to approve Z21-13 at 1250 Main to allow a 4-foot variance to the required landscape buffer between the parking lot and right of way, thereby allowing a six-foot buffer between the parking lot and right of way.

Condition

Applicant must provide the required number of trees and shrubs that are dictated in the ordinance, but that they may be placed elsewhere on the property if necessary.

The landscaping buffer must begin 24.3 feet south of the north property line and end 7.7 feet north of the south property line.

A minimum of four shrubs and one tree must be placed in the front buffer.

Finding of Fact

The existing building location limits the ability to have a 10-foot buffer.

There was a roll call vote.

Yes: Burrows, Devine, Elliott, Krol, Silvers

MOTION PASSED 5-0

7. COMMISSIONER COMMENTS

Krol asked that an extension number for the City Clerk be added to the agenda cover sheet section on persons needing accommodations.

Bolhuis said she would let board members know whether Zoom and/or hybrid meetings will continue.

8. REPORTS AND CORRESPONDENCE

Elliott said the Appointments Committee is working on appointing a new member and alternate for the ZBA.

10. ADJOURNMENT

A motion to adjourn was offered at 8:41 p.m. by Krol and seconded by Burrows.

There was a roll call vote.

Yes: Burrows, Devine, Elliott, Krol, Silvers

MOTION PASSED 5-0

City of Plymouth Zoning Board of Appeals Notice Thursday, July 1, 2021 – 7:00 p.m. ity Hall Commission Chamber/Cultural Contor

City Hall Commission Chamber/Cultural Center

201 S. Main Street Plymouth, Michigan 48170 Website: www.plymouthmi.gov Phone: (734) 453-1234 ext. 232

A regular meeting of the Zoning Board of Appeals will be held on Thursday, July 1, 2021 at 7:00 P.M. in the Commission Chambers of City Hall or at the Cultural Center to consider the following:

Z21-14 Non-Use Variance Request for 1112 Hartsough
Distance between the house and garage
Side yard setback for a detached garage
Zoned: R-1, Single Family Residential
Applicant: Jolynne Mercieca & Scott Lachowicz

*The finalized meeting location will be posted on the City's website

All interested persons are invited to attend.

In compliance with the Americans with Disabilities Act, the City of Plymouth will provide necessary reasonable auxiliary aids and services, such as signers for the hearing impaired and audiotapes of printed materials being considered at the meeting/hearing, to individuals with disabilities. Requests for auxiliary aids or services may be made by writing or calling the following:

Maureen Brodie, ADA Coordinator 201 S. Main Street Plymouth, MI 48170, (734) 453-1234, Ext. 234

Publish: Thursday, June 17, 2021



CITY OF PLYMOUTH COMMUNITY DEVELOPMENT

201 South Main Street Plymouth, MI 48170 Ph. 734-453-1234 ext. 232 Website: www.plymouthmi.gov

TO: Zoning Board of Appeals Commissioners

FROM: Greta Bolhuis, Assistant Community Development Director

DATE: June 25, 2021


RE: 1112 Hartsough, Non-Use Variance Request

Scott Lachowicz, applicant, is requesting a non-use variance to construct a detached garage. The property is 50 feet wide by 108 feet deep. The property is 5,400 square feet and is zoned R-1, Single Family Residential.

Section 78-260 (6) states "No detached accessory building in residential districts shall be located closer than three feet to any side or rear lot line. In those instances where the rear lot line is coterminous with an alley right-of-way, the accessory building shall be no closer than one foot to such rear lot line. In no instance shall an accessory structure be located within a dedicated easement right-of-way." The proposed detached garage is 2.5 feet from the side property line. A variance of 0.5 feet is required.

Section 78-260 (13) states "Detached accessory structures must be located a minimum of ten feet from the principal structure on site." The proposed detached garage is 5 feet from the rear of the principal structure. A variance of 5 feet is required.

Should you have any questions regarding this agenda item, please contact me directly.

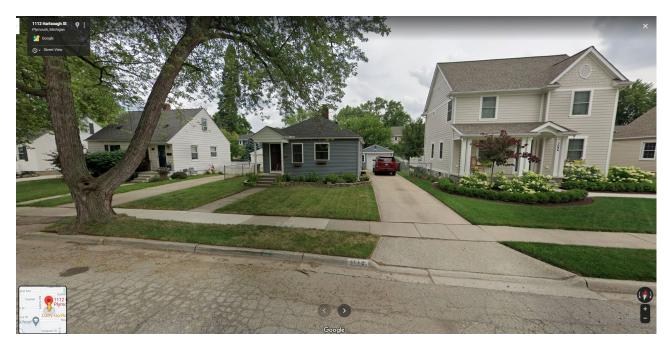





DIMENSIONAL (NON-USE) VARIANCE APPLICATION

Community Development Department

201 S. Main Street Plymouth, MI 48170 Ph. 734-453-1234 ext. 232 Website: www.plymouthmi.gov

6/8/21

Type of Variance Request: DIMENSIONAL – Common regulations subject to dimensional (non-use) variance requests: setbacks, signs, height, parking regulations, lot coverage, and bulk or landscaping restrictions. Uniqueness: odd shape, small size, wetland, creek, natural features, big trees or slopes.

Address of Property

Scott Lachowicz

Jolynne Mercieca

Applicant Name

Property Owner

Applicant Name Property Owner

1112 Hartsough St Plymouth MI 48170

Address City State Zip

Scottlacho@gmail.com 248.798.3736

Email Phone

1112 Hartsough St, Plymouth MI, 48170

Three Basic Functions of the ZBA:

- 1. Interpreting the zoning ordinance (text and map) and nonconforming situations.
- 2. Deciding appeals on administrative decisions, special land uses, or PUDs.
- 3. Granting variance requests.

Standards for Dimensional (Non-Use) Variance: Click here to see full ordinance language.

- 1. Ordinance unreasonably prevents the owner from using the property for what it is zoned
- 2. Variance will do substantial justice to the applicant, and the surrounding community
- 3. Problem is due to the unique circumstances of the property
- 4. Problem is not self-created

A quorum (3 members) is required for approval of all non-use variance requests.

The Zoning Board of Appeals meets the first Thursday of each month at 7:00PM. The completed application and necessary/applicable plans must be filed with a fee of \$250.00 for single family projects or \$500.00 for multi-family and non-residential. Visit the City's website for submittal deadlines and meeting dates: Zoning Board of Appeals. Submit ten (10) hardcopies of the application and plans including but not limited to survey, plot map, building plans, and photos. One complete digital set of application materials shall be submitted on a flashdrive or emailed to mailto:plans@plymouthmi.gov (maximum file size is 100 MB).

The Zoning Board of Appeals will not accept incomplete applications. Signature of property owner and applicant, as well as notarization is required for every application. There are notaries located in City Hall. The Community Development Department has the right to remove an item from the agenda due to incompleteness.

1 Effective Date: 4/14/2021

2 Effective Date: 4/14/2021

Please answer all the following questions as they relate to the dimensional variance, use additional sheets as necessary:

1.	What are the practical difficulties preventing compliance with the ordinance? Are these practical
	difficulties an exception or unique to the property compared to other properties in the City? (NOTE:
	The ZBA cannot grant a variance because it is inconvenient or more expensive to build to ordinance
	or solely to satisfy aesthetic concerns.) We have DTE power lines running through our backyard and they have a 6' easement that we are not allowed to encroach on. Thus we are asking for a variance from the city to encroach on the 10' setback for accessory structures (garage).
2.	What effect will the variance have on neighboring properties?
3.	Is the practical difficulty which prevents you from complying with the ordinance self-imposed? How
	did the practical difficulty come about? (NOTE: The ZBA has generally found that purely aesthetic
	consideration and self-created hardships are unacceptable grounds for a variance.)
	we need to have a garage and cannot shift our proposed garage back (North) due to DTE's easement on the power lines. The garage is necessary to store a vehicle, yard equipment and additional
	storage.
4.	Why do the ordinance restrictions unreasonably prevent the owner from using the property for a permitted purpose? due to the combination of the DTE easement and the 10' setback rule for accessory structures we would be unable to have a standard depth garage required
	for adequate storage.
	DTE Rejection letter attached for reference
	ereby depose and say that all the above statements and the statements contained in the papers submitted rewith are true and correct:
Sig	nature of Property Owner Signature of Applicant
Su	bscribed and sworn before me thisday of, 20
	Notary Public
	My Commission expires

Effective Date: 4/14/2021



DTE Energy Right of Way Department – SW Region Engineering, Planning & Design Electric Distribution Operations 8001 Haggerty Road Belleville, MI 48111

Date: May 24, 2021

Jolynne Mercieca Scott Lachowicz 1112 Hartsough Street Plymouth, Michigan 48170

Re: Encroachment Request – 1112 Hartsough Street, Plymouth, Michigan 48170, Lot 89, Sunshine Acres Subdivision.

Parcel Number: 49-010-04-0089-000

Dear Ms. Mercieca and Mr. Lachowicz,

Please be advised that the DTE Electric Company (DTEE) has reviewed your request for an encroachment on the existing utility easement at the above-captioned property.

Upon review of the documents you submitted and inspection of your property by a Service Planner, we are unable to grant your encroachment request. Proper clearances must be adhered to at all times for safety purposes and to allow for future DTEE repairs and maintenance within the easement. According to the site plan you submitted and the construction that was completed prior to us being contacted; proper clearances cannot be met. Therefore, we must deny your request.

Please feel free to contact me, if you have any questions or concerns.

Sincerely,

Kyra Froelich

Right of Way Facilitator

DTE Energy - Electric Distribution Engineering, Planning & Design – SW Region

kyra.froelich@dteenergy.com | Cell: 734-308-3499

Design Name: Garage Design04

Design ID: 330858688679

Estimate ID: 9170




How to purchase at the store

- 1. Take this packet to any Menards store.
- 2. Have a building materials team member enter the design number into the Garage Estimator Search Saved Designs page.
- 3. Apply the design to System V to create the material list.
- 4. Take the purchase documents to the register and pay.

How to recall and purchase a saved design at home

- 1. Go to Menards.com.
- 2. Select the Garage Estimator from the Project Center.
- 3. Select Search Saved Design.
- 4. Log into your account.
- 5. Select the saved design to load back into the estimator.
- 6. Add your Garage to the cart and purchase.

Garage Image

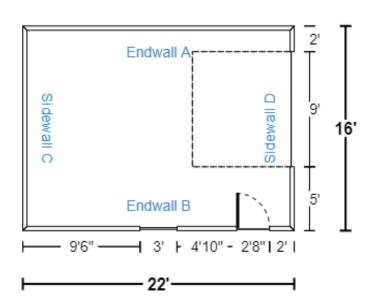

Estimated Price: \$11,438.08

* Today's estimated price, future pricing may go up or down. Tax, labor, and delivery not included.

Floor type (concrete, dirt, gravel) is NOT included in estimated price. The floor type is used in the calculation of materials needed. Labor, foundation, steel beams, paint, electrical, heating, plumbing, and delivery are also NOT included in estimated price. This is an estimate. It is only for general price information. This is not an offer and there can be no legally binding contract between the parties based on this estimate. The prices stated herein are subject to change depending upon the market conditions. The prices stated on this estimate are not firm for any time period unless specifically written otherwise on this form. The availability of materials is subject to inventory conditions.

Design is larges Gasiage of Asigns incurred by the guest who relies on prices set forth hereined on the availability plans in a supply and the straight of the set of

Estimate ID: 9170

MENARDS MAKES NO REPRESENTATIONS, ORAL, WRITTEN OR OTHERWISE THAT THE MATERIALS LISTED ARE SUITABLE FOR ANY PURPOSE BEING CONSIDERED BY THE GUEST. BECAUSE OF WIDE VARIATIONS IN CODES, THERE ARE NO REPRESENTATIONS THAT THE MATERIALS LISTED HEREIN MEET YOUR CODE REQUIREMENTS. THE PLANS AND/OR DESIGNS PROVIDED ARE NOT ENGINEERED. LOCAL CODE OR ZONING REGULATIONS MAY REQUIRE SUCH STRUCTURES TO BE PROFESSIONALLY ENGINEERED AND CERTIFIED PRIOR TO CONSTRUCTION.

Design Name: Garage Design04

Design ID: 330858688679

Estimate ID: 9170



Dimensions

Wall Configurations

*Illustration may not depict all options selected.




Commander® 32"W x 80"H Primed Steel 6-Panel Exterior Door

Northview Aspen 36"W x 24"H Vinyl Sliding Window with Builtin J-Channel



Ideal Door® 4-Star 9' x 8' White Select Value Insulated Garage Door



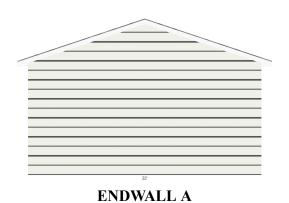

Design Name: Garage Design04

Designt Ins \$30858688679 tter, gable accents, are not displayed if selections Buy GARAGE

Estimate ID: 9170

Materials

Building Info

Building Width: 22'
Building Length: 16'
Building Height: 10'
Wall Framing Stud: 2" x 4"

Roof Framing: Truss Construction

Truss Type: Common Roof Pitch: 4/12 Pitch

Eave Overhang: 1'
Gable Overhang: 1'
Concrete Block Option: None

Anchor bolt: Grip Fast 1/2" x 10" HDG Anchor Bolt w/ Nut &

Washer

Custom Garage Plan: No I do not need a custom building plan

Wall Info

Siding Material Types: Fiber Cement Siding

Fiber Cement Siding:

AlluraTM 5/16" x 12" x 12' Smooth Fiber Cement Lap

Siding

Accent Material Type:

Wainscot Material Type:

None

None

Wall Sheathing: 7/16" OSB (Oriented Strand Board)

House Wrap: Kimberly-Clark BLOCK-IT®9'x75'House Wrap

Gable Vents: Novik® 12" x 12" Square Gable Vent

Design Name: Garage Design04

Design ID: 330858688679

Estimate ID: 9170

Design & Buy GARAGE

1/2" OSB (Oriented Strand Board)

Roof Info

Roof Sheathing:

$\boldsymbol{\mathcal{E}}$,
Roofing Material Type:	Architectural Shingle
Architectural Roofing:	Owens Corning® TruDefinition® Duration® Limited Lifetime Warranty Architectural Shingles (32.8 sq. ft.) - Estate Gray
Roof Underlayment:	Owens Corning® ProArmor® Synthetic Roofing Underlayment 42" x 286' (1,000 sq. ft.)
Ice and Water Barrier:	Owens Corning® WeatherLock® G Granulated Self-Sealing Ice and Water Barrier 3' x 66.7'(200sq.ft)
Fascia material Type:	Fiber Cement Fascia
Fascia:	1x6 Smooth Fiber Cement Fascia (15-yr Paint Warranty) - Snow White
Soffit material Type:	Fiber Cement Soffit
Soffit:	1/4X12' Fiber Cement Textured Vented Soffit (15 Yr Paint Warranty) - Snow White
Roof Edge:	12' Aluminum Style D Roof Edging - White
Gutter material Type:	Aluminum
Gutter:	Spectra Metals 5" x 10' K-Style Aluminum Gutter - White
Ridge Vent:	Owens Corning® VentSure® 11-1/4" x 20' Shingle Over Ridge Vent
Roof Vents:	None

Openings

Entry Door: Commander® 32"W x 80"H Primed Steel 6-Panel Exterior Door

Overhead Door: Ideal Door® 4-Star 9' x 8' White Select Value Insulated

Garage Door

Windows: Northview Aspen 36"W x 24"H Vinyl Sliding Window

with Built-in J-Channel

Additional Options

Ceiling Insulation:NoneWall Insulation:NoneCeiling Finish:None

None

NæliginName: Garage Design04 Design ID: 330858688679 Estimate ID: 9170

Design & Buy GARAGE

Design Name: Garage Design04 Design ID: 330858688679 Estimate ID: 9170



Job	Truss	Truss Type	Qty	Ply	
QTRSU0000160	T1	COMMON	14	1	Job Reference (optional)

Midwest Manufacturing, Eau Claire, WI

Run: 8.100 s Apr 21 2017 Print: 8.100 s Apr 21 2017 MiTek Industries, Inc. Mon May 15 15:10:19 2017 Page: 1
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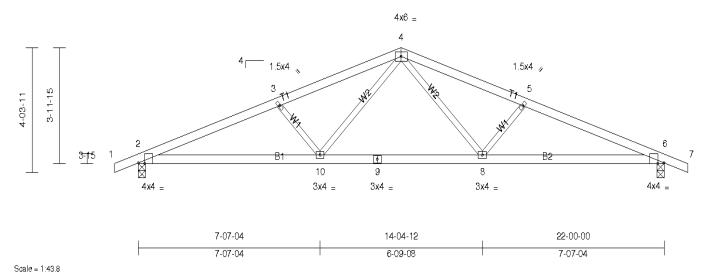


Plate Offsets (X, Y): [2:3-02,Edge], [6:3-02,Edge]

Loading	(psf)	Spacing	2-00-00	CSI		DEFL	in	(loc)	I/defl	Ľ∕d	PLATES	GRIP
TCLL (roof)	30.0	Plate Grip DOL	1.15	TC	0.53	Vert(LL)	-0.15	8-10	>999	240	MT20	197/144
Snow (Ps/Pg)	27.7/40.0	Lumber DOL	1.15	BC	0.77	Vert(CT)	-0.26	6-8	>991	180		
TCDL	7.0	Rep Stress Incr	YES	₩B	0.41	Horz(CT)	0.07	6	n/a	n/a		
BCLL	0.0*	Code	IRC2015/TPI2014	Matrix-R		` '						
BCDL	10.0										Weight: 66 lb	FT = 0%

 LUMBER
 BRACING

 TOP CHORD
 2x4 SPF No.2
 TOP CHORD

 BOT CHORD
 2x4 SPF No.2
 BOT CHORD

BOT CHORD 2x4 SPF No.2 WEBS 2x3 SPF Stud

REACTIONS (lb/size) 2=1050/3-08, (min. 1-12), 6=1050/3-08, (min. 1-12)

Max Horiz 2=-52(LC 15)

Max Uplift 2=-115(LC 10), 6=-115(LC 11) Max Grav 2=1105(LC 2), 6=1105(LC 2)

FORCES (lb) - Max. Comp./Max. Ten. - All forces 250 (lb) or less except when shown.

TOP CHORD 2-3=-2411/348, 3-4=-2108/300, 4-5=-2108/300, 5-6=-2411/348 BOT CHORD 2-10=-271/2219, 9-10=-143/1520, 8-9=-143/1520, 6-8=-271/2219 WEBS 3-10=-473/153, 4-10=-37/681, 4-8=-37/681, 5-8=-473/153

NOTES

- 1) Unbalanced roof live loads have been considered for this design.
- 2) Wind: ASCE 7-10; Vult=115mph (3-second gust) Vasd=91mph, TCDL=4.2psf, BCDL=6.0psf, h=25ft; Cat. II; Exp B; enclosed; MWFRS (envelope) exterior(2) zone and C-C Exterior(2) zone; cantilever left and right exposed; end vertical left and right exposed; C-C for members and forces & MWFRS for reactions shown; Lumber DOL=1.60 plate grip DOL=1.60
- 3) TCLL: ASCE 7-10; Pr=30.0 psf (roof live load: Lumber DOL=1.15 Plate DOL=1.15); Pg=40.0 psf (ground snow); Ps=27.7 psf (roof snow: Lumber DOL=1.15 Plate DOL=1.15); Category II; Exp B; Fully Exp.; Ct=1.1
- 4) Roof design snow load has been reduced to account for slope.
- 5) Unbalanced snow loads have been considered for this design.
- 5) This truss has been designed for greater of min roof live load of 12.0 psf or 1.00 times flat roof load of 27.7 psf on overhangs non-concurrent with other live loads
- 7) This truss has been designed for a 10.0 psf bottom chord live load nonconcurrent with any other live loads.
- This truss has been designed for a live load of 20.0psf on the bottom chord in all areas where a rectangle 3-6-0 tall by 2-0-0 wide will fit between the bottom chord and any other members
- 9) Provide mechanical connection (by others) of truss to bearing plate capable of withstanding 115 lb uplift at joint 2 and 115 lb uplift at joint 6.
- 10) This truss is designed in accordance with the 2015 International Residential Code sections R502.11.1 and R802.10.2 and referenced standard ANSI/TPI 1.

LOAD CASE(S) Standard

Structural wood sheathing directly applied or 3-0-15 oc purlins. Rigid ceiling directly applied or 10-0-0 oc bracing.

MiTek recommends that Stabilizers and required cross bracing be installed during truss erection, in accordance with Stabilizer Installation guide.

Design Name: Garage Design04 Design ID: 330858688679

Estimate ID: 9170



Job	Truss	Truss Type	Qty	Ply	
QTREC0651618	T1E	Common Supported Gable	2	1	Job Reference (optional)


Midwest Manufacturing, Eau Claire, WI

Run: 8.4 S 0 May 13 2020 Print: 8.400 S May 13 2020 MiTek Industries, Inc. Wed Sep 30 16:55:37

Page: 1

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Scale = 1:44.7

Loading	(psf)	Spacing	2-0-0	CSI		DEFL	in	(loc)	l/defl	L/d	PLATES	GRIP
TCLL (roof)	35.0	Plate Grip DOL	1.15	TC	0.30	Vert(LL)	n/a		n/a	999	MT20	197/144
Snow (Ps/Pg)	34.7/50.0	Lumber DOL	1.15	BC	0.17	Vert(CT)	n/a		n/a	999		
TCDL	7.0	Rep Stress Incr	YES	WB	0.13	Horz(CT)	0.00	10	n/a	n/a		
BCLL	0.0 *	Code	IRC2015/TPI2014	Matrix-R								
BCDL	10.0										Weight: 67 lb	FT = 15%

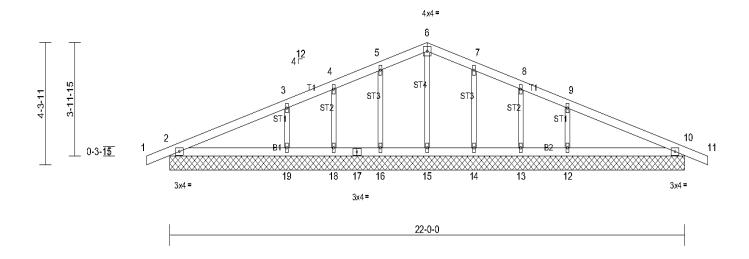BRACING

TOP CHORD

BOT CHORD

LUMBER TOP CHORD 2x4 SPF No.2 BOT CHORD 2x4 SPF No.2

2x3 SPF Stud

OTHERS REACTIONS All bearings 22-0-0.

(lb) - Max Horiz 2=52 (LC 14)

Max Uplift All uplift 100 (lb) or less at joint(s) 2, 10, 12, 13, 14, 16, 18, 19 Max Grav All reactions 250 (lb) or less at joint(s) 13, 15, 18 except 2=310

(LC 2), 10=310 (LC 2), 12=548 (LC 22), 14=311 (LC 22), 16=311 (LC 21), 19=548 (LC 21)

FORCES (lb) - Max. Comp./Max. Ten. - All forces 250 (lb) or less except when shown.

WEBS 5-16=-256/61, 3-19=-412/120, 7-14=-256/61, 9-12=-412/120

NOTES

Unbalanced roof live loads have been considered for this design.

- Wind: ASCE 7-10; Vult=115mph (3-second gust) Vasd=91mph; TCDL=4.2psf; BCDL=6.0psf; h=25ft; Cat. II; Exp B; Enclosed; MWFRS (envelope) exterior zone and C-C Exterior (2) zone; cantilever left and right exposed; end vertical left and right exposed; C-C for members and forces & MWFRS for reactions shown; Lumber DOL=1.60 plate grip DOL=1.60
- Truss designed for wind loads in the plane of the truss only. For studs exposed to wind (normal to the face), see Standard Industry Gable End Details as applicable, or consult 3) qualified building designer as per ANSI/TPI 1.
- TCLL: ASCE 7-10; Pr=35.0 psf (roof live load: Lumber DOL=1.15 Plate DOL=1.15); Pg=50.0 psf (ground snow); Ps=34.6 psf (roof snow: Lumber DOL=1.15 Plate DOL=1.15); Category II; Exp B; Fully Exp.; Ct=1.10
- Roof design snow load has been reduced to account for slope.
- Unbalanced snow loads have been considered for this design.
- This truss has been designed for greater of min roof live load of 12.0 psf or 1.00 times flat roof load of 34.6 psf on overhangs non-concurrent with other live loads. 7)
- All plates are 1.5x4 MT20 unless otherwise indicated.
- 9) Gable requires continuous bottom chord bearing.
- 10) Gable studs spaced at 2-0-0 oc.
- This truss has been designed for a 10.0 psf bottom chord live load nonconcurrent with any other live loads.
- * This truss has been designed for a live load of 20 0psf on the bottom chord in all areas where a rectangle 3-06-00 tall by 2-00-00 wide will fit between the bottom chord and

Structural wood sheathing directly applied or 6-0-0 oc purlins. Rigid ceiling directly applied or 10-0-0 oc bracing.

MiTek recommends that Stabilizers and required cross bracing be installed during truss erection, in accordance with Stabilizer Installation guide

- 13) Provide mechanical connection (by others) of truss to bearing plate capable of withstanding 100 lb uplift at joint(s) 2, 16, 18, 19, 14, 13, 12, 10.

 14) This truss is designed in accordance with the 2015 International Residential Code sections R502.11.1 and R802.10.2 and referenced standard ANSI/TPI 1.

LOAD CASE(S) Standard

LOT 89 AND 1/2 VACATED ALLEY "SUNSHINE ACRES SUBDIVISION" OF PART OF THE NORTHEAST 1/4 OF SECTION 34, TOWN 1 SOUTH, RANGE 8 EAST, CITY OF PLYMOUTH, WAYNE COUNTY, MICHIGAN, AS RECORDED IN LIBER 40 OF PLATS, PAGE 3 OF WAYNE COUNTY RECORDS, SUBLECT TO EASEMENTS OF RECORD. 98 99 100 101 102 1/2 VACATED ALLEY 50.00' R.& M. S.S.B. 1/2 VACATED ALLEY OverHead Utility Wires OverHead Utility Wires **LOT 89** 2.4' 14.2 87 91 90 88 Old Garage ż . ሜ Garage this was the house was 2.5' demo'd with demo'd except 108.00 the house for the foundation. . જ 14.5' we put on a 24.10 108.00 13 foot addition and went up. # 1112 This box 64.1' HOUSE WITH represents **BASEMENT** the footprint of the house with the addition. MCKINLEY ST. this portion in red is not to scale. 50.00' R.&▼M. 0.4' to Drive 300.00' R.& M. 231.00' R.& M. # 1112 HARTSOUGH STREET

50' WIDE R.O.W.

LEGEND
R. RECORD DISTANCE
M. MEASURED DISTANCE

F.S.B. FOUND STEEL BAR F.I.P. FOUND IRON PIPE S.S.B. SET STEEL BAR

AVERAGE FRONT SETBACK:	AVERAGE FRONT SETBACK:
MEASURED TO HOUSE FOUNDATIONS	MEASURED TO COVERED PORCHES
ADDRESS #1180 = 23.7'	ADDRESS #1180 = 19.7' COVERED PORCH
ADDRESS #1144 = 24.9'	ADDRESS #1144 = 24.9' FOUNDATION
ADDRESS #1140 = 23.9'	ADDRESS #1140 = 19.9' COVERED PORCH
ADDRESS #1128 = 24.0'	ADDRESS #1128 = 24.0' FOUNDATION
ADDRESS #1112 HARTSOUGH = SITE	ADDRESS #1112 HARTSOUGH = SITE
ADDRESS #1096 = 24.0'	ADDRESS #1096 = 20.2' COVERED PORCH
ADDRESS #1076 = 23.8'	ADDRESS #1076 = 20.0' COVERED PORCH
ADDRESS #1062 = 24.0'	ADDRESS #1062 = 24.0' FOUNDATION
ADDRESS #1044 = 24.2'	ADDRESS #1044 = 24.2' FOUNDATION
TOTAL / 8 HOMES = 192.5 / 8 = 24.06	TOTAL / 8 HOMES = 176.9 / 8 = 22.11
X 0.9 = AVERAGE FRONT SETBACK 21.7'	X 0.9 = AVERAGE FRONT SETBACK 19.9'


LOT SURVEY


CLIENT: SCOTT LACHOWCZ 1112 HARTSOUGH PLYMOUTH, MI. 48170

8-4-20		691 WNG STREET	DRAWN BY: GW
юв но.: 20—07—025	ambit	Plymouth, Mi. 48170 ph. 800.221.5263 ph. 734.455.5501	CHECK: PPP
CALE: 1"=20'	land surveyors, inc.	fax 877.837.5267 www.ambitsurveyors.com	SHEET: 1 OF 1

ALL FOOTINGS ARE DESIGNED FOR 3000 P.S.F. SOIL BRG. CAPACITY \$ 30 P.S.F. ROOF SNOW LOAD. FOR YARYING CONDITIONS REFER TO TABLE R403.1(1), R403.1(2), \$ R403.1(3) OF THE 2015 IRC.

- ALL COLUMNS SHOWN SHALL BE 3" DIA, SCHEDULE 40 STANDARD STEEL PIPE COLUMN ON 30" \times 30" \times 18" DEEP CONC, FTG, TOP OF CONCRETE FTG. TO BE 4" BELOW FINISH BASEMENT SLAB. (TYPICAL UNLESS NOTED
- WHERE STEEL BEAMS REST ON FOUNDATION WALLS, SIZE BEAM POCKET APPROPRIATELY AND SHIM AS REQUIRED.
- AS REQUIRED DROP FOYER FLOOR SHEATHING 3/4" FOR MUDSET TILE INSTALLATION
- 4. YERIFY ALL UTILITY LOCATIONS W/ BUILDER.
- PROVIDE GUARDRAIL AT STAIRS DURING CONSTRUCTION.
- PROVIDE LADDERING UNDER ANY WALL RUNNING PARALLEL W/ JOIST THAT DOES NOT LAND DIRECTLY ON A JOIST
- PROVIDE SQUASH BLOCKS UNDER ALL BEARING CONDITIONS.
- B. GROUT SOLID @ BEARING CONDITIONS WHERE BLOCK IS USED.
- PROVIDE 2" imes 24" (MIN, R-IO) RIGID PERIMETER INSULATION AT ALL BASEMENT SLABS THAT ARE LESS THAN 42" BELOW EXTERIOR FINISHED GRADE

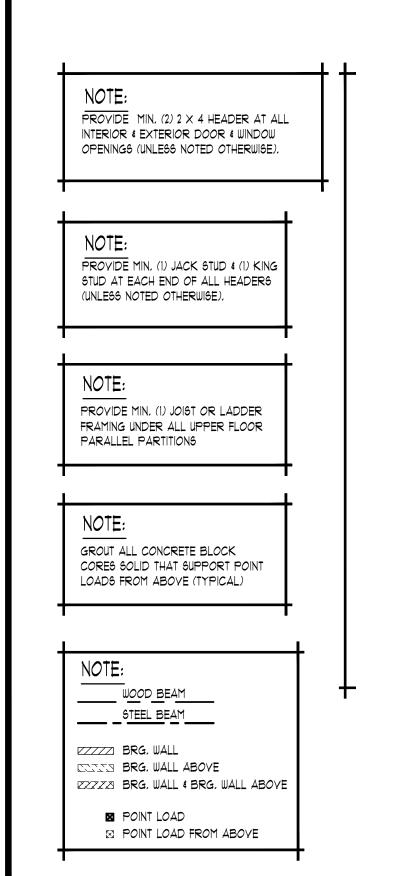

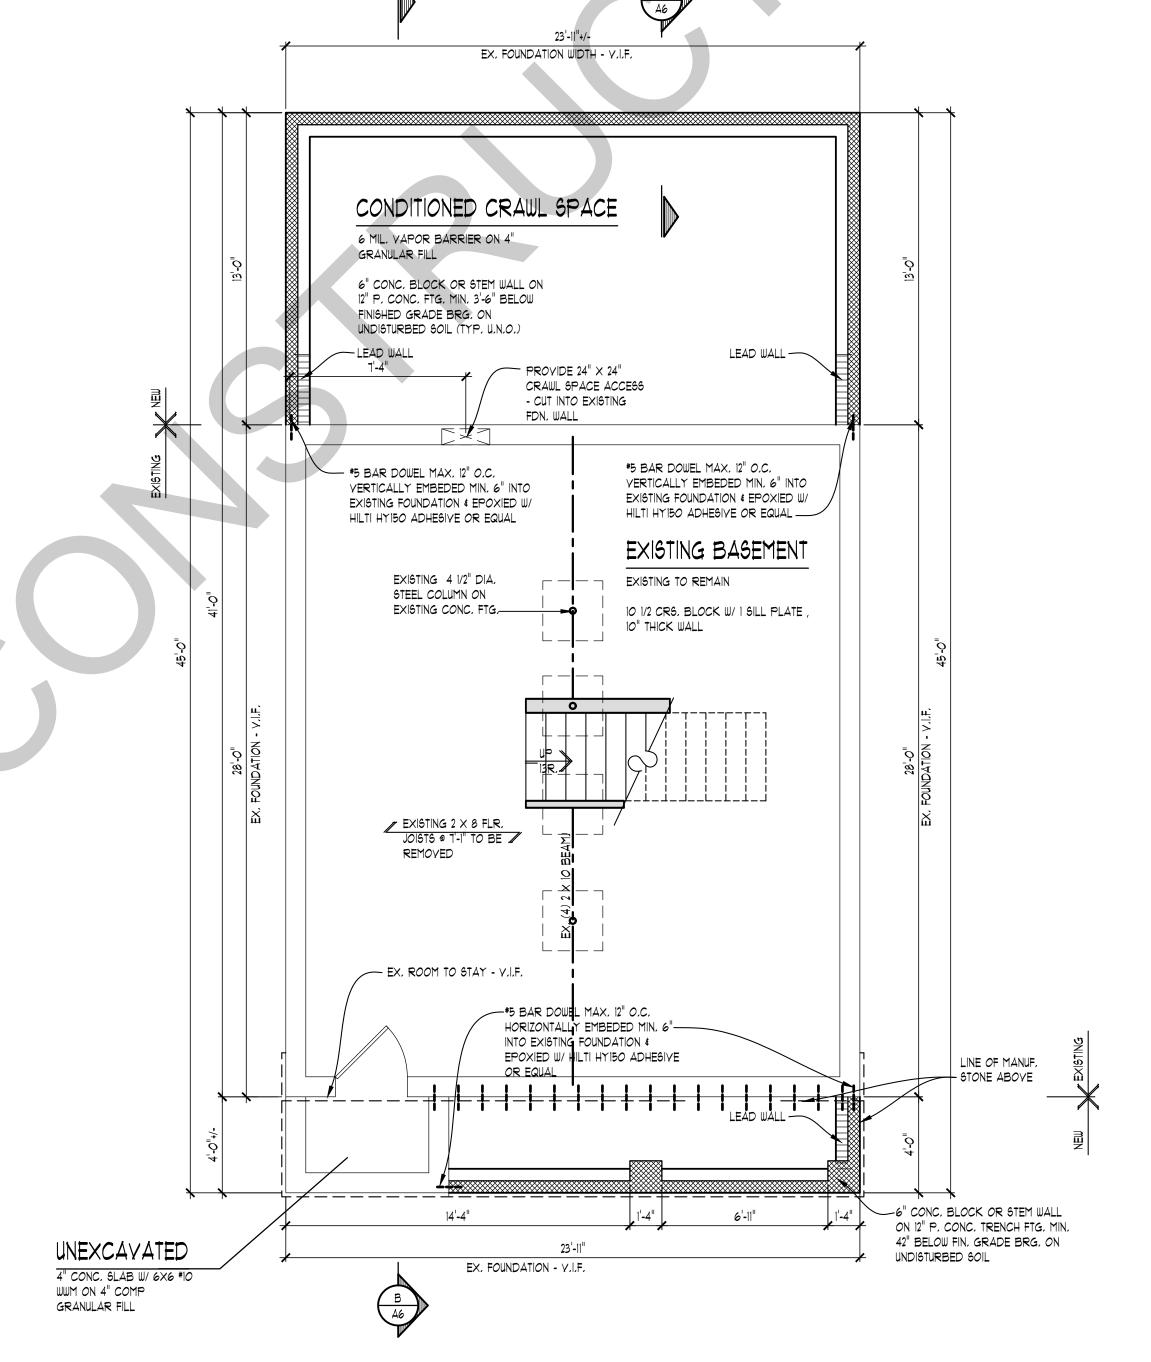

INFORMATION DEEMED RELIABLE BUT NOT GUARANTEED. ALL DIMENSIONS ARE APPROXIMATE. TRUSS MANUFACTURER AND GENERAL CONTRACTOR TO YERIFY ALL FIELD CONDITIONS INCLUDING BUT NOT LIMITED TO:

- EXTERIOR WALL THICKNESS
- EXISTING ROOF PITCH
- EXISTING HEEL HEIGHT
- OYERHANG DIMENSIONS
- OYERALL DIMENSIONS ACROSS TOP PLATES
- EXISTING FLOOR JOIST AND ROOF FRAMING DIRECTION
- PRIOR TO BIDDING / TRUSS FABRICATION / MATERIAL TAKEOFF

FOUNDATION PLAN SCALE: 1/4" = 1'-0"

LOT INFORMATION: CITY/TOWNSHIP: PLYMOUTH ZONING: MINIMUM SETBACKS: FRONT REAR SIDES 6' (12 TOTAL) MAX ROOF HEIGHT: LOT COYERAGE: (35%) 5400 \$Q.FT. x (%) = 1890 \$Q.FT. MAX 1081 \$Q.FT. BUILDING FOOTPRINT / LOT AREA = (20%)

TOTAL FLOOR AREA: 2041 SQ.FT. (31.9 (40%)

FLOOR AREA RATIO (FAR): 5400 SQ.FT. LOT AREA x 0.4 = <u>2160</u> SQ.FT. MAX FLOOR AREA FIRST FLOOR: 981 SQ.FT. SECOND FLOOR: 1066 SQ.FT. ATTACHED GARAGE: O SQ.FT.



ASSOCIATES

26030 PONTIAC TRAIL SOUTH LYON, MI 48178 PHONE: (248)-446-1960 FAX: (248)-446-1961

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DRAWN: \mathbf{AG} CHECKED: REVIEW 10-1-2020 FINAL: REVISION 10-5-2020

> SCALE: PER PLAN

SHEET# $\mathbf{A}1$

PLAN NOTES

INTERIOR WALLS:

1/2" GYPSUM WALL BOARD ON EACH SIDE OF 2x4 WOOD STUDS @ 16" O.C. 3 1/2" THICK TYPICAL (UNLESS NOTED OTHERWISE). ALL DIMENSION TAKEN FROM STUD EDGES

EXTERIOR WALLS:

SIDING AND/OR MASONRY WITH AIRSPACE, MOISTURE BARRIER PAPER (HOUSE WRAP) ON 1/16" O.S.B. SHEATHING ON 2X4 WOOD STUDS @ 16" O.C. OR AS NOTED, MIN. R-20 WALL CONSTRUCTION, 1/2" GYPSUM WALL BOARD (GLUE & SCREW). WALL TO BE 4" THICK WITH SIDING (TYPICAL UNLESS NOTED OTHERWISE). ALL DIMENSION TAKEN FROM FRAMING (FLOOR PLANS) OR FOUNDATION CORNERS (FOUNDATION PLAN)

- 1. OPENINGS BETWEEN THE GARAGE AND RESIDENCE SHALL BE EQUIPPED WITH 20-MINUTE FIRE RATED DOORS (OR EQUIVALENT PER 2015 MRC SECTION R302.5.1).
- 2. YENT ALL EXHAUST FANS TO EXTERIOR.
- 3. WHEN POSSIBLE DIRECT ALL FLUES AND VENTS THAT PENETRATE ROOF BEHIND MAIN RIDGE.
- 4. INSTALL WATER SUPPLY AND DRAIN BOX (GREY BOX) AT WASHING MACHINE LOCATION.
- 5. USE MOISTURE RESISTANT DRYWALL AT ALL AREAS SUSCEPTIBLE TO MOISTURE.
- 6. ALL FIRST FLOOR INTERIOR DOORS TO BE FRAMED 6'-8" TALL, ALL SECOND FLOOR INTERIOR DOORS TO BE FRAMED 6'-8" UNLESS NOTED OTHERWISE. VERIFY W/ BUILDER
- 1. PROVIDE GUARDRAIL AT STAIRS DURING CONSTRUCTION.
- 8. PROVIDE SQUASH BLOCKS UNDER ALL BEARING CONDITIONS.
- 9. GARAGE WALLS TO BE 2X6 STUDS IF OVER 10'-0" TALL.



NEW NEW

EXISTING STUD WALL
TO REMAIN

NOTE

PORCH CLG, FINISH PER BUILDER'S SPEC.

NOTE:

SD/C
SD/C
ALL SMOKE & CARBON MONOXIDE
DETECTORS INTERCONNECTED W/

BATTERY BACK-UP PER CODE,

NOTE:

DOOR & WINDOW LOCATIONS:

ALL DOORS & WINDOWS ARE ASSUMED TO BE EITHER IN THE CENTER OF THE WALL MASS OR MIN. 4 INCHES FROM PERPENDICULAR WALL FOR CASING UNLESS NOTED OTHERWISE

NOTE:

VERIFY DROPPED FLOOR AREAS FOR TILE WITH BUILDER

FIREPLACE NOTE

ALL FIREPLACE DIMENSIONS & ROUGH OPENINGS TO BE VERIFIED W/ MANUFACTURER SPECS INCLUDING BUT NOT LIMITED TO WIDTH, DEPTH, HEIGHT, CHIMNEY CLEARANCES, ETC. IT IS THE RESPONSIBILITY OF THE CONTRACTOR TO PROVIDE ALL SPECS TO CARPENTER PRIOR TO FRAMING

FIRE SEPARATION NOTE

FIRE SEPARATION (R302.6)

GARAGE SPACE BENEATH HABITABLE ROOMS SHALL BE SEPARATED FROM ALL HABITABLE ROOMS ABOVE BY NOT LESS THAN 5/8-INCH TYPE X GYPSUM BOARD OR EQUIVALENT. WHERE THE SEPARATION IS A FLOOR-CEILING ASSEMBLY, THE STRUCTURE SUPPORTING THE SEPARATION SHALL ALSO BE PROTECTED BY NOT LESS THAN I/2-INCH GYPSUM BOARD OR EQUIVALENT. ALL OTHER GARAGE SPACE SHALL BE SEPARATED FROM THE RESIDENCE AND ITS ATTIC AREA BY NOT LESS THAN I/2-INCH GYPSUM BOARD APPLIED TO THE GARAGE SIDE. DROP CLG. UNDER FLR. ABV. (ENCLOSE MECHANICAL AND STRUCTURAL ELEMENTS) VERIFY W/ BLDR.

NOTE


PROVIDE MIN. (2) 2 X 4 HEADER AT ALL INTERIOR & EXTERIOR DOOR & WINDOW OPENINGS (UNLESS NOTED OTHERWISE).

NOT

PROVIDE MIN. (1) JACK STUD & (1) KING STUD AT EACH END OF ALL HEADERS (UNLESS NOTED OTHERWISE).

NOT

PROVIDE MIN. (1) JOIST OR LADDER
FRAMING UNDER ALL UPPER FLOOR
PARALLEL PARTITIONS

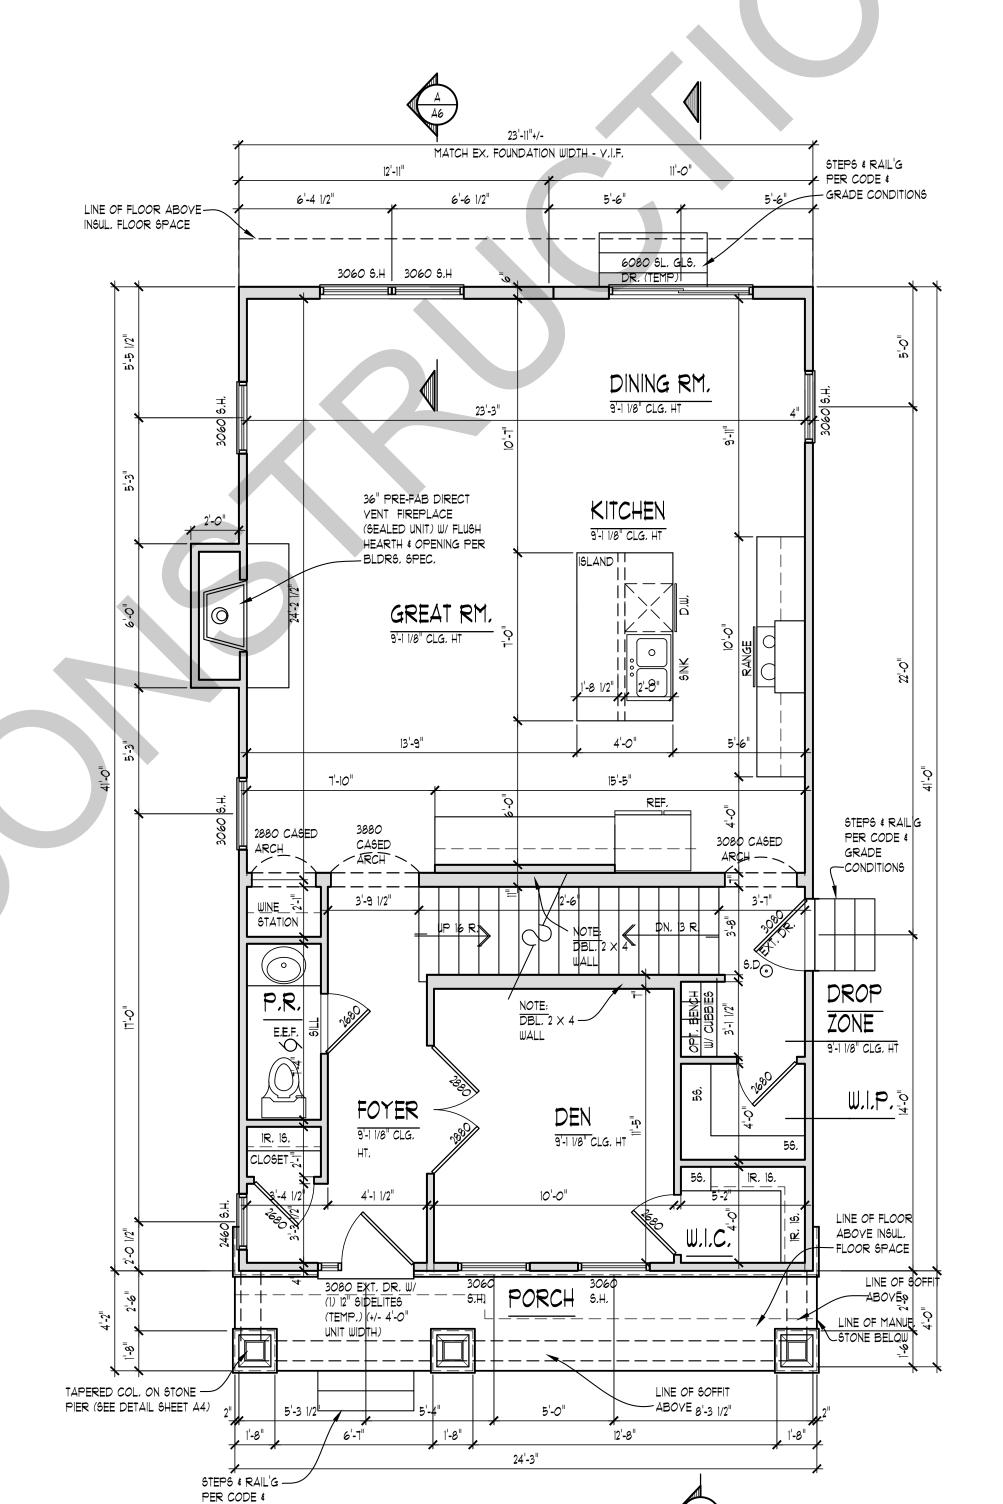

FIRST FLOOR PLAN

GRADE CONDITIONS

NOT

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- EXTERIOR WALL THICKNESS
- EXISTING ROOF PITCH
- EXISTING HEEL HEIGHT
- OYERHANG DIMENSIONS
- OYERALL DIMENSIONS ACROSS TOP PLATES
- EXISTING FLOOR JOIST AND ROOF FRAMING DIRECTION
- PRIOR TO BIDDING / TRUSS FABRICATION / MATERIAL TAKEOFF

AREA SUMMARY:

OYERALL FLOOR AREA:
FIRST FLOOR 981 S.F.
SECOND FLOOR 1066 S.F.
TOTAL AREA 2041 S.F.



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&
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REPORTED TO THE DESIGNER IN WRITTEN FORM IMMEDIATELY
-CALL MISS DIG AT 680-482-7271 3 DAYS PRIOR TO ANY EXCAVATA
-CONSTRUCTION IS THE SOLE RESPONSIBILITY OF THE PERMIT HOLD

EVERGREEN
DEVELOPMENT
ERCIECA-LACHOWICZ
RESIDENCE
112 HARTSOUGH ST.

JOB No. 20-230

DRAWN: AG
CHECKED:
REVIEW 10-1-2020

FINAL: -

REVISION 10-5-2020

SCALE: PER PLAN

SHEET #

A2

PI AN NOTES


INTERIOR WALLS:

1/2" GYPSUM WALL BOARD ON EACH SIDE OF 2x4 WOOD STUDS @ 16" O.C. 3 1/2" THICK TYPICAL (UNLESS NOTED OTHERWISE). ALL DIMENSION TAKEN FROM STUD EDGES

EXTERIOR WALLS:

SIDING AND/OR MASONRY WITH AIRSPACE, MOISTURE BARRIER PAPER (HOUSE WRAP) ON 1/16" O.S.B. SHEATHING ON 2X4 WOOD STUDS @ 16" O.C. OR AS NOTED, MIN. R-20 WALL CONSTRUCTION, 1/2" GYPSUM WALL BOARD (GLUE & SCREW). WALL TO BE 4" THICK WITH SIDING (TYPICAL UNLESS NOTED OTHERWISE). ALL DIMENSION TAKEN FROM FRAMING (FLOOR PLANS) OR FOUNDATION CORNERS (FOUNDATION PLAN)

- 1. OPENINGS BETWEEN THE GARAGE AND RESIDENCE SHALL BE EQUIPPED WITH 20-MINUTE FIRE RATED DOORS (OR EQUIVALENT PER 2015 MRC SECTION P302 5 1)
- 2. YENT ALL EXHAUST FANS TO EXTERIOR.
- 3. WHEN POSSIBLE DIRECT ALL FLUES AND VENTS THAT PENETRATE ROOF BEHIND MAIN RIDGE.
- 4. INSTALL WATER SUPPLY AND DRAIN BOX (GREY BOX) AT WASHING MACHINE LOCATION.
- 5. USE MOISTURE RESISTANT DRYWALL AT ALL AREAS SUSCEPTIBLE TO MOISTURE.
- 6. ALL FIRST FLOOR INTERIOR DOORS TO BE FRAMED 6'-8" TALL, ALL SECOND FLOOR INTERIOR DOORS TO BE FRAMED 6'-8" UNLESS NOTED OTHERWISE. YERIFY W/ BUILDER
- PROVIDE GUARDRAIL AT STAIRS DURING CONSTRUCTION.
- 8. PROVIDE SQUASH BLOCKS UNDER ALL BEARING CONDITIONS.
- 9. GARAGE WALLS TO BE 2X6 STUDS IF OVER 10'-0" TALL.

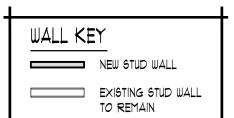

NOTE:

\$.D. ©

\$D/C ©

ALL \$MOKE & CARBON MONOXIDE

DETECTORS INTERCONNECTED W/
BATTERY BACK-UP PER CODE.

NO 1 :: DOOR & WINDOW LOCATIONS:

DOOR & WINDOW LOCATIONS

ALL DOORS & WINDOWS ARE ASSUMED TO BE EITHER IN THE CENTER OF THE WALL MASS OR MIN, 4 INCHES FROM PERPENDICULAR WALL FOR CASING UNLESS NOTED OTHERWISE

NOTE

VERIFY DROPPED FLOOR AREAS

NOT


PROVIDE MIN. (2) 2 X 4 HEADER AT ALL INTERIOR & EXTERIOR DOOR & WINDOW OPENINGS (UNLESS NOTED OTHERWISE).

NOT

PROVIDE MIN. (1) JACK STUD & (1) KING STUD AT EACH END OF ALL HEADERS (UNLESS NOTED OTHERWISE).

NOTE

PROVIDE MIN, (1) JOIST OR LADDER FRAMING UNDER ALL UPPER FLOOR PARALLEL PARTITIONS

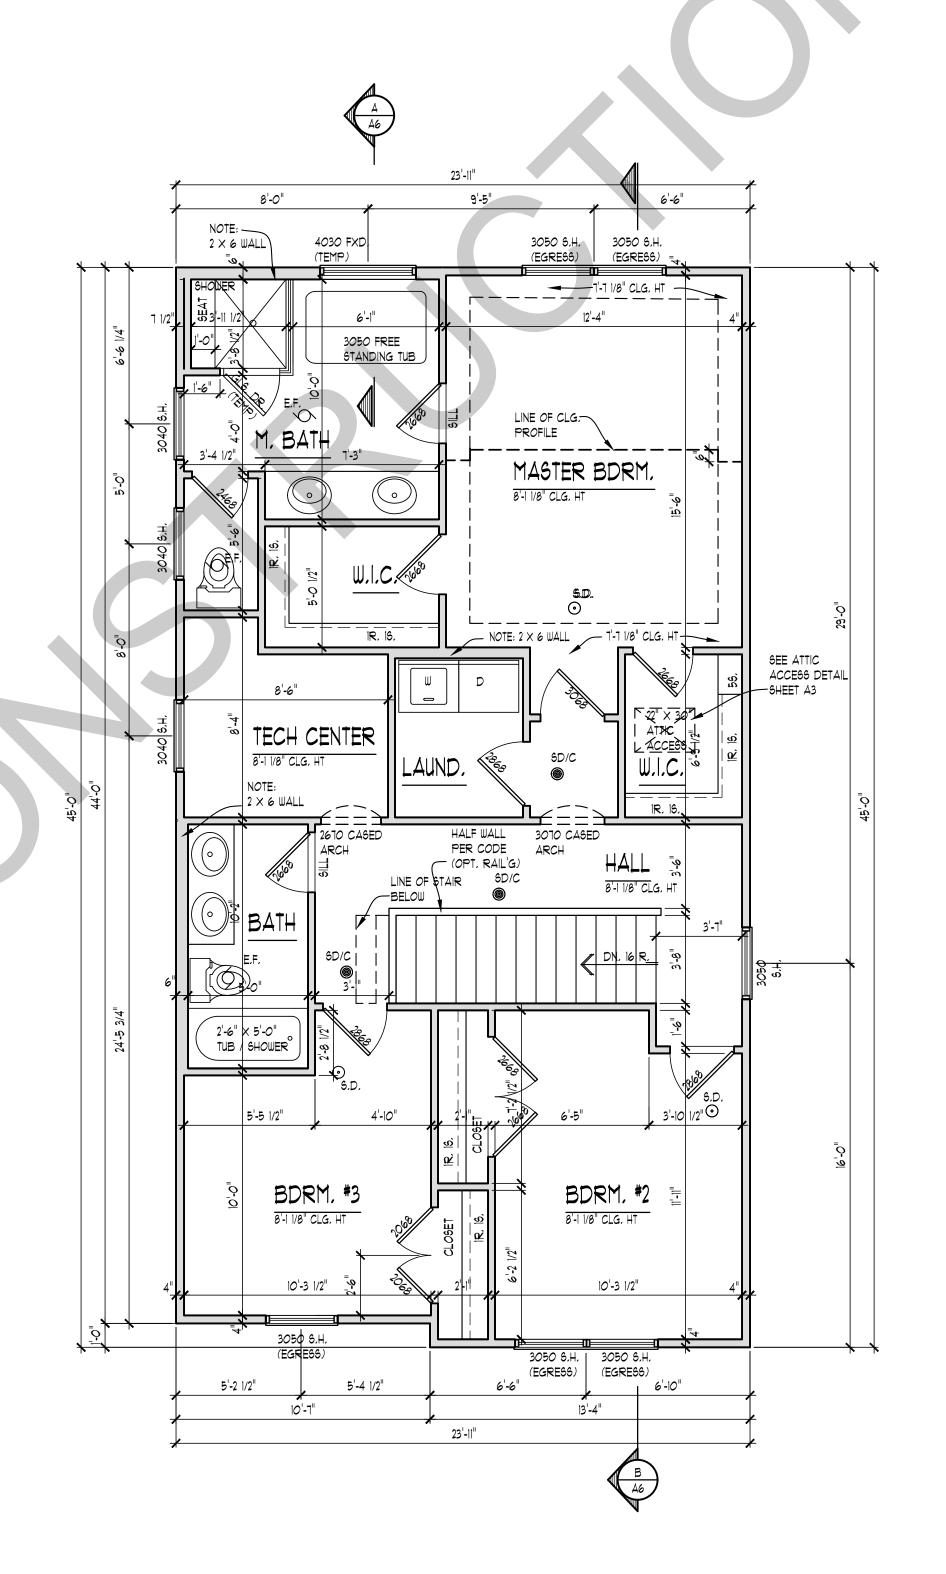

SECOND FLOOR PLAN

SCALE: 1/4" = 1'-0"



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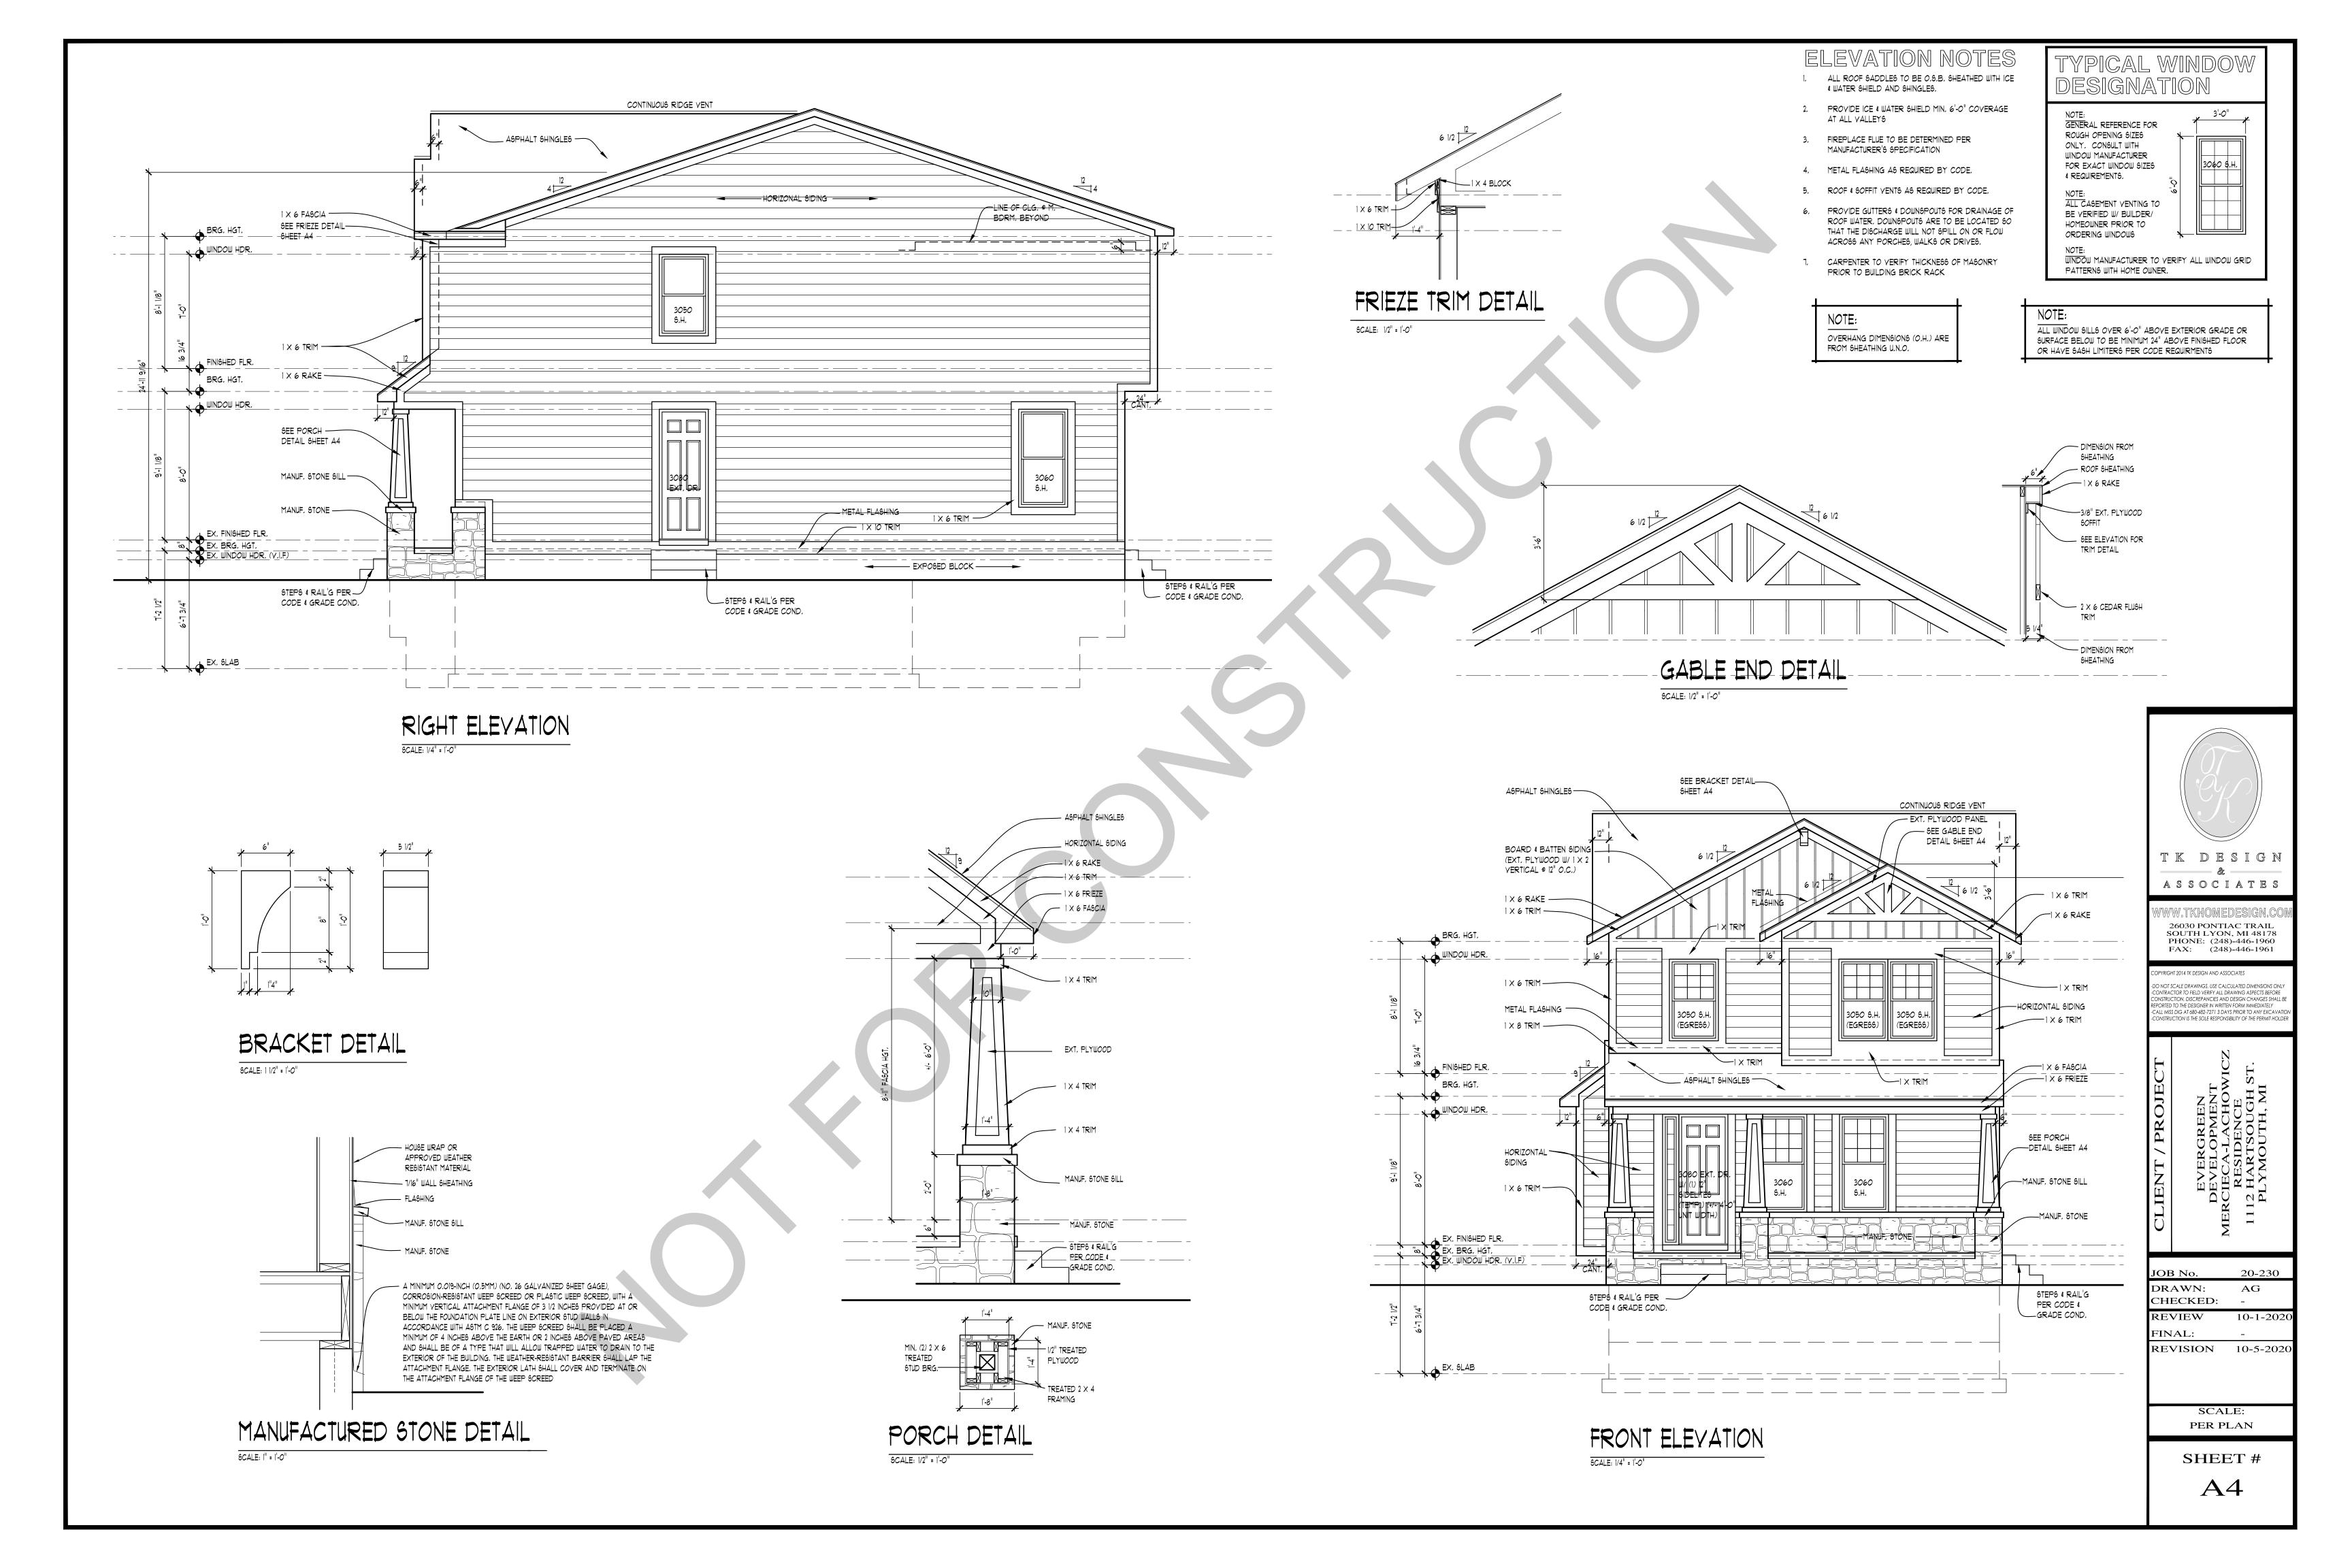
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-CONSTRUCTION IS THE SOLE RESPONSIBILITY OF THE PERMIT HOLDE


EVERGREEN
DEVELOPMENT
AERCIECA-LACHOWICZ
RESIDENCE
1112 HARTSOUGH ST.
PI YMOLITH MI


JOB No.	20-230
DRAWN:	AG
CHECKED:	_
REVIEW	10-1-2020
FINAL:	-
REVISION	10-5-2020

SCALE: PER PLAN

SHEET #
A3



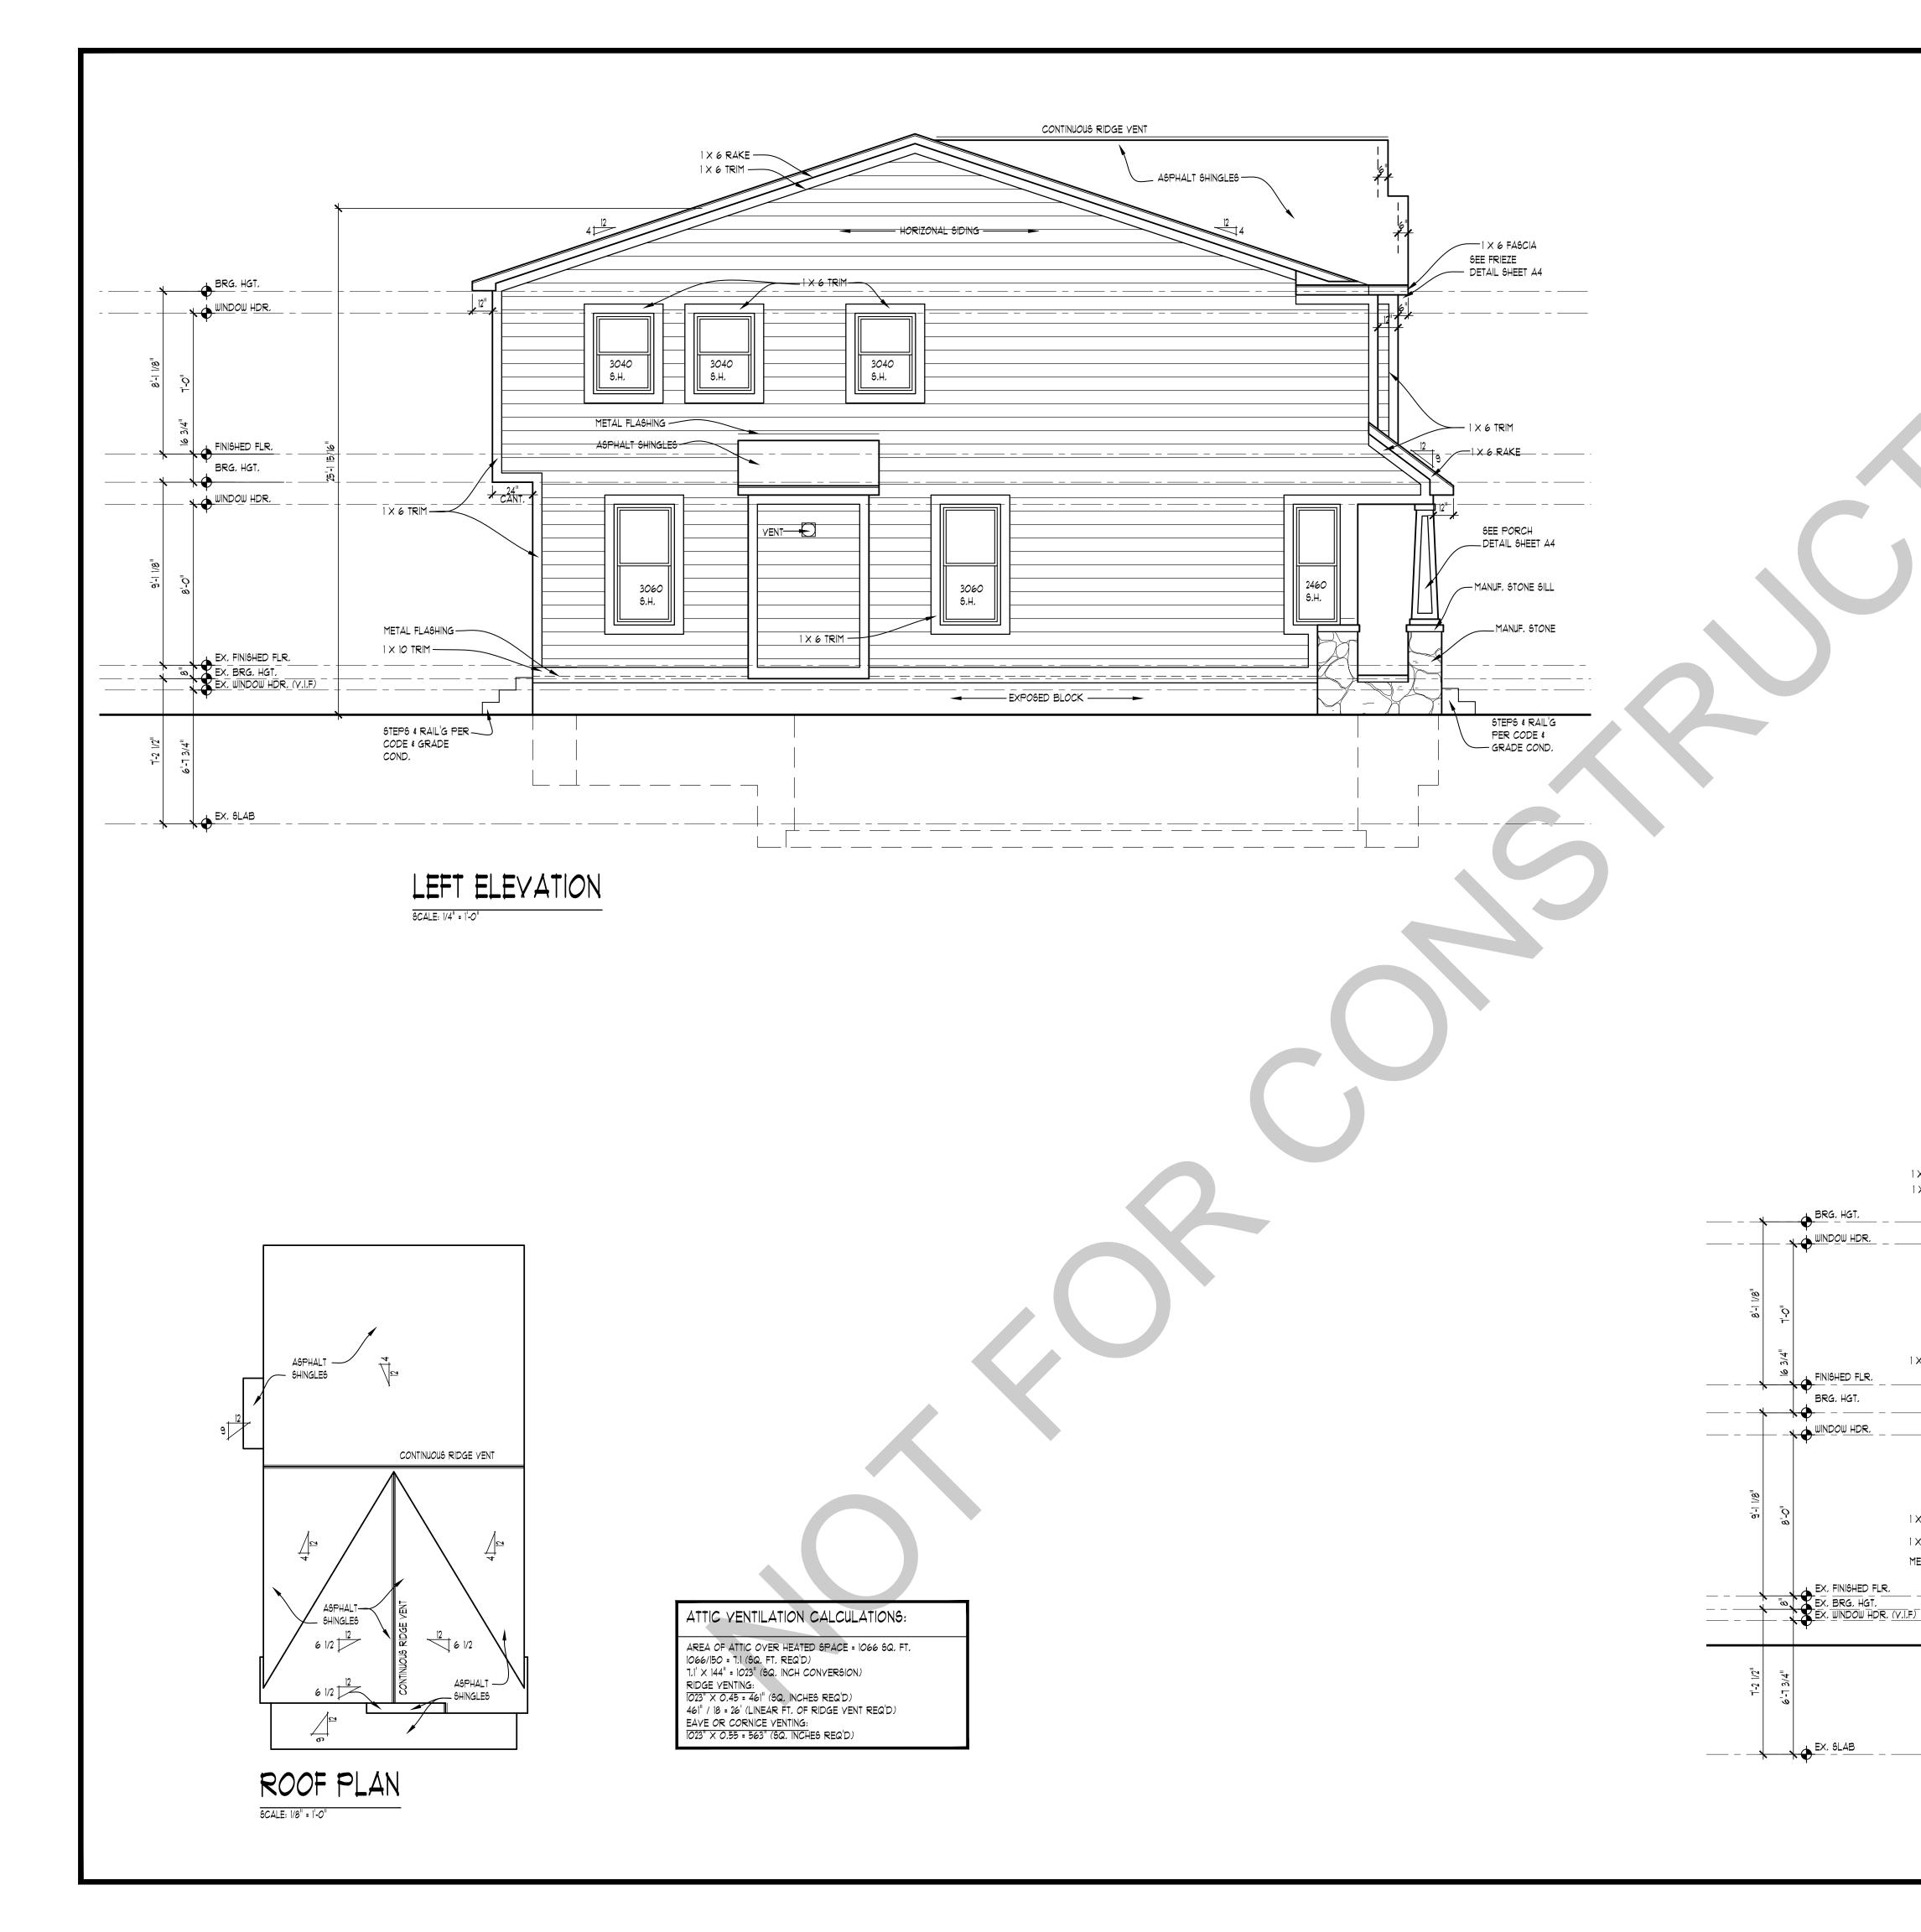

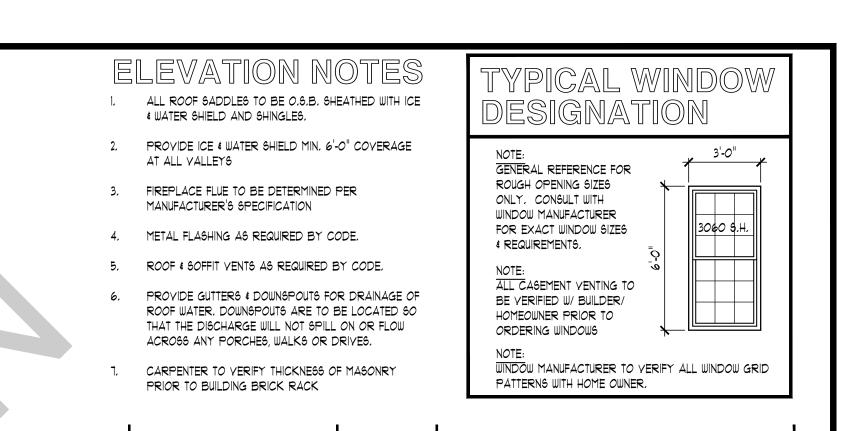

CONTINUOUS RIDGE YENT

3060 S.H.

. ASPHALT SHINGLES —

LINE OF CLG, © M, BDRM, BEYOND

HORIZONAL SIDING

4040 FXD. (TEMP)

> 3060 5.H.

EXPOSED BLOCK ---


3050 S.H. (EGRESS) (EGRESS)

6080 SL. GLS. DR. (TEMP) NOTE:

OVERHANG DIMENSIONS (O.H.) ARE FROM SHEATHING U.N.O.

NOTE:

ALL WINDOW SILLS OVER 6'-0" ABOVE EXTERIOR GRADE OR SURFACE BELOW TO BE MINIMUM 24" ABOVE FINISHED FLOOR OR HAVE SASH LIMITERS PER CODE REQUIRMENTS

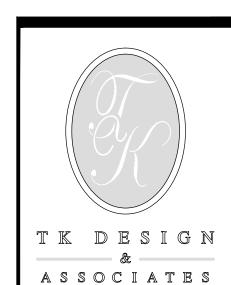

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CLIENT / PROJECT
EVERGREEN
DEVELOPMENT
AERCIECA-LACHOWICZ
RESIDENCE
1112 HARTSOUGH ST.
PLYMOUTH, MI

JOB No. 20-230

DRAWN: AG
CHECKED:
REVIEW 10-1-2020

FINAL:
REVISION 10-5-2020

SCALE: PER PLAN

SHEET #
A5

REAR ELEVATION

STEPS & RAIL'G PER -

- CODE & GRADE COND.


5CΔ| F₂ 1/4" = 1'-0"


1 X 6 FASCIA ----

1 × 6 FRIEZE —

1 X 6 TRIM ---

1 X 10 TRIM ———— METAL FLASHING —

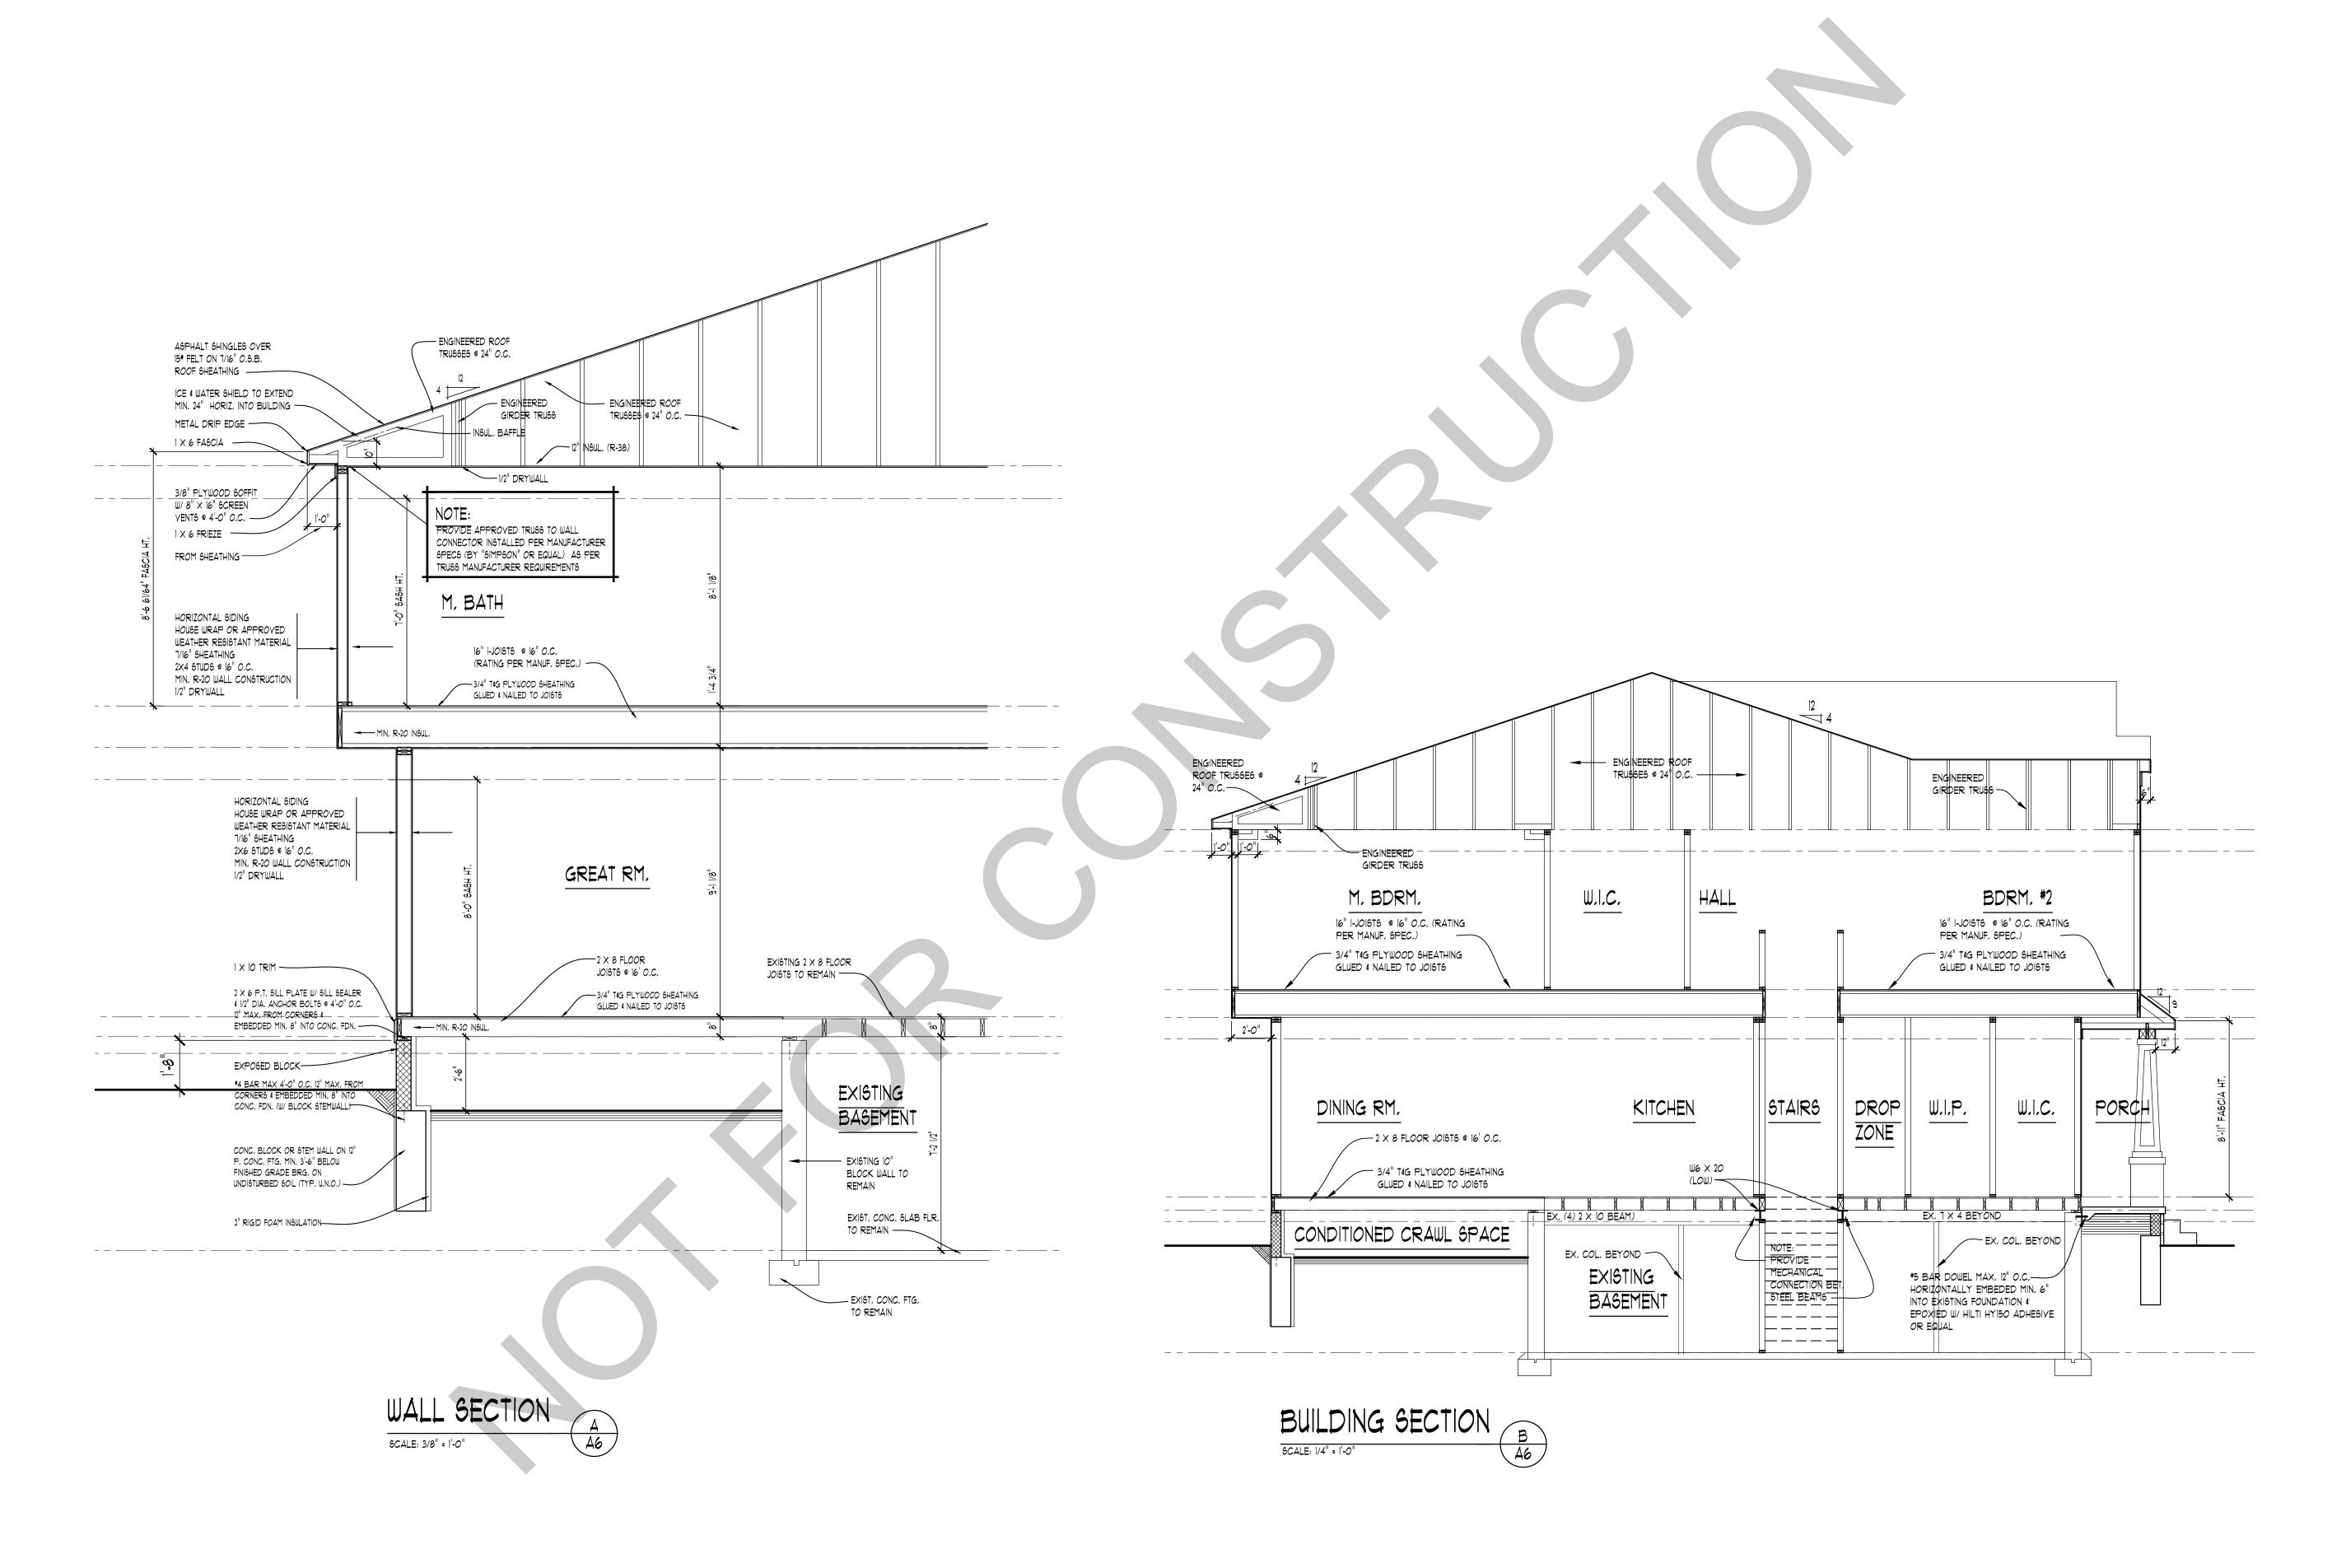

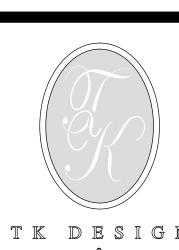

TK DESIGN ASSOCIATES

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20-230 DRAWN: \mathbf{AG} CHECKED: REVIEW 10-1-2020 FINAL: REVISION 10-5-2020

PER PLAN

SHEET#

SCALE:

A6